


extend blockwork over existing section of external stone wall removed cut ends of existing wall (original building) extg RWP new 650 wide x 250 deep new 650 wide x 250 deep strip foundations strip foundations new blockwork cavity external wall new blockwork cavity external wall (forming new gable end to Unit 1) (forming new gable end to Unit 1) UNIT 2 existing internal partitions removed — UNIT 1 existing stone wall removed new 100mm security wall (temporary) new 450 wide x 250 deep strip foundation existing external walls removed (previous extension)

O1 GROUNDFLOOR PLAN as proposed 1/50

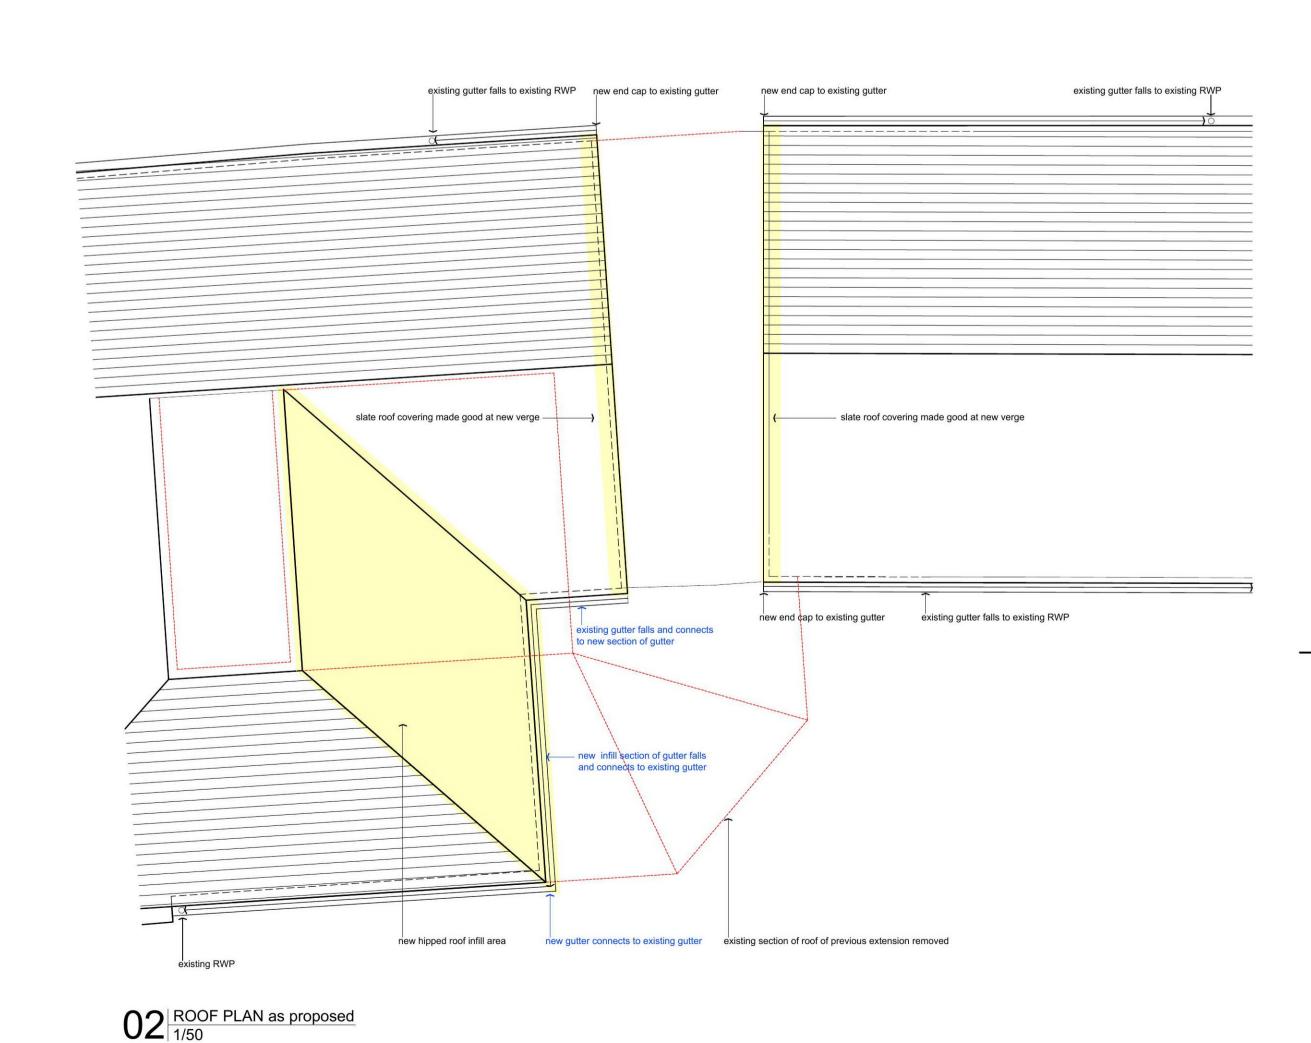


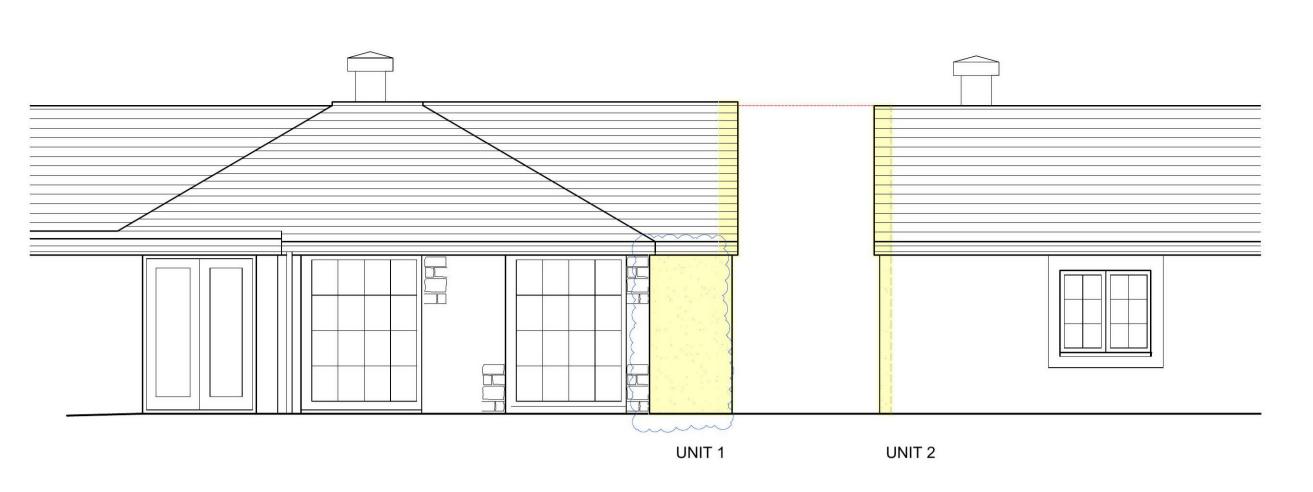

PRONT ELEVATION as proposed 1/50

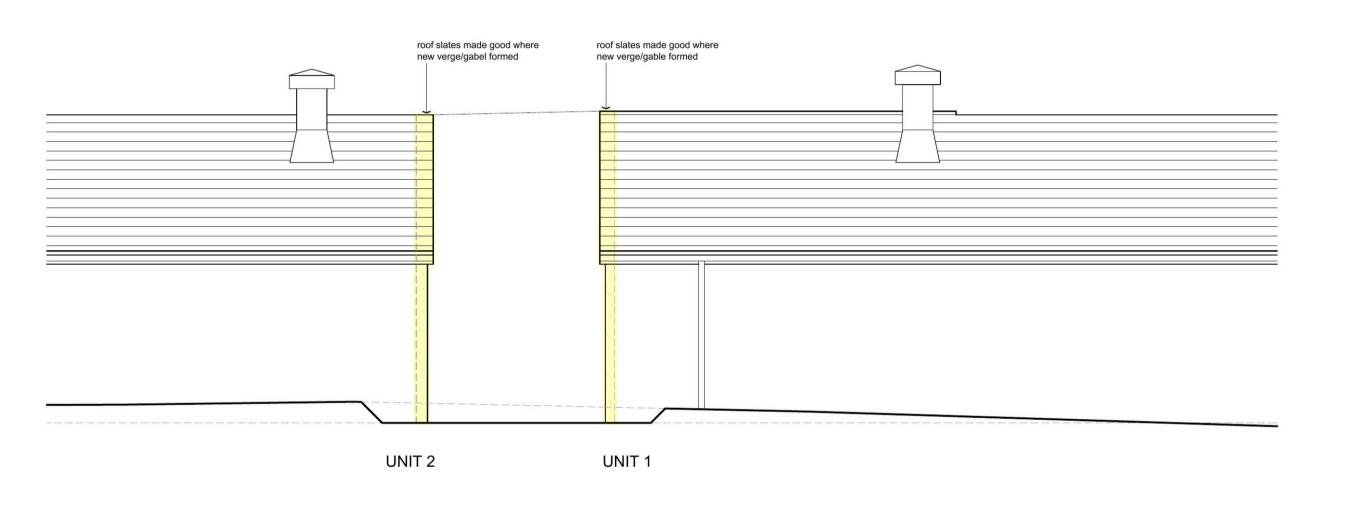

REAR ELEVATION as proposed 1/50

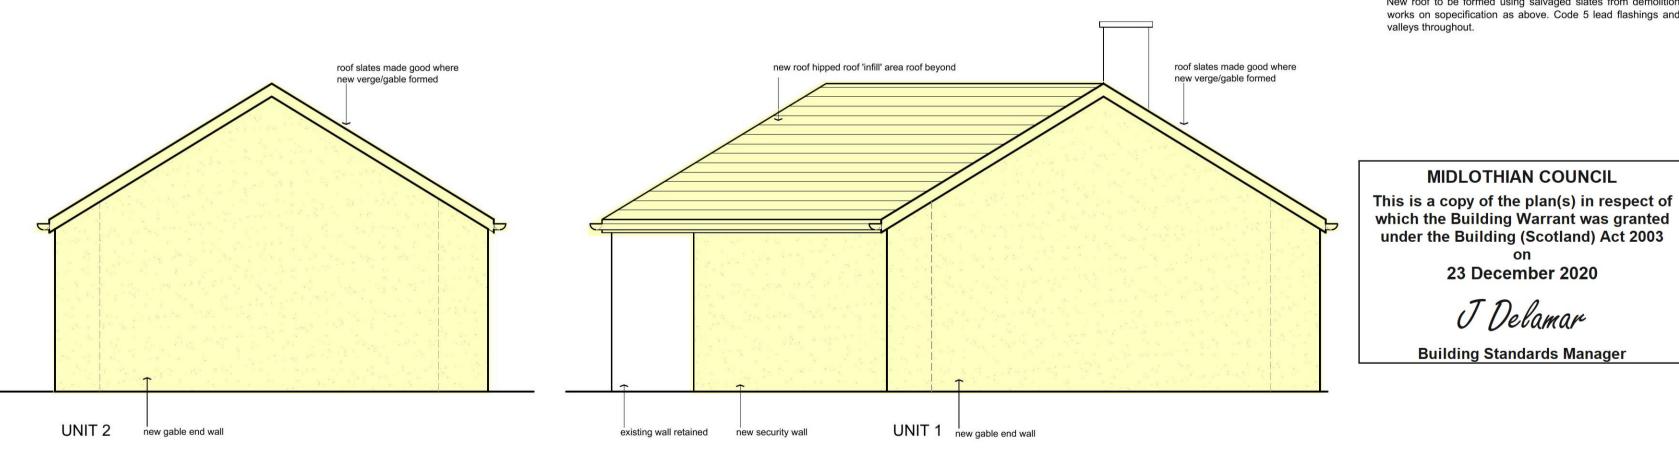

05 SIDE ELEVATION as proposed 1/50

06 SIDE ELEVATION as proposed 1/50

2 3 SCALE metres

BUILDING CONTROL NOTES

guidance.

the works.

FOUNDATIONS

floor slabs

New Gable Walls and Security Wall

and reinforcement specification.

GROUND FLOOR ALTERATIONS

NEW WALLS CONSTRUCTION

installation of vertical DPC.

to match existing adjacent walls.

details and specification for gable ladders.

for ventilation) on roof structures.

New Hipped Infill Roof

valleys throughout.

Security Wall (Temporary)

Engineer;s specification.

ROOF ALTERATIONS New Gable Ends

DOWNTAKINGS/REMOVALS All removals shown in a broken red line.

All new works are to be in accordance with The Building (Scotland) Regulations 2004 and all current amendments.

All new works, products and processes are to be accordance with the relevant British Standards and manufacturers'

Contractor to notify the Verifier and Service Authorities of proposed works not less than 1 week before commencing site

All demolitions to comply with BS6187:2000 'Code of Practice

for Demolition' and current regulations relating to demolitions

Provide and maintain during the execution of the works all shoring, strutting, needling and other supports as may be required to preserve the stability of the buildings affected by the structure. Masonry above all wall slappings is to be securely supported during building operations as considered

Remove all redundant services where encountered. Remove all redundant services where encountered. Existing drainage

Strip out non-loadbearing walls, partitions, doors etc as

Provide and maintain during the execution of the works, all shoring, strutting and needling and other supports as may be required to preserve the stability of the buildings affected by

Refer to Structural Engineer's details and specification on drawing ref CE5129-01 for all structural aspects of the work.

Top of foundations to be minimum of 450mm below ground

Existing floor to be made good at junction with new walls. New 1200g DPMs to overlap existing DPms and new DPCs. New concrete infill areas to align and match depth of existing

Blockwork of new cavity gable walls and new single skin securtity wall to be tied into existing with stainless steel wall starter sytem ties as manufacturers instructions. Allow for

Gable Walls

New gable walls construction to comprise of 100mm blockwork inner leaf, 100mm cavity and 100mm blockwork all to Structural Engineer's specification. Render external finish

Temporary security wall to comprose of single 100mm blcokwork leaf with central 440x215 pier all to Structural

Form new verge at new gable ends - see Structural Engineer's

Area of existing roof to be made good using salvaged slate from demolition works on Tyvek (or equal and approved) breathable membrane, to ventilate roof (lapped joints minimum 150mm horizontally and vertically and secured with clout nails) on 22mm sarking boards (min. 3mm air gap between boards

New roof to be formed using salvaged slates from demolition works on sopecification as above. Code 5 lead flashings and

MIDLOTHIAN COUNCIL

under the Building (Scotland) Act 2003

23 December 2020

Building Standards Manager

All DPCs to be minimum of 150mm above ground level. All DPCs and DPMs to be continuous and lapped to existing. See Structural Engineer's drawing for size of strip foundations

issued by the Health and Safety Executive.

appropriate by the structural engineer.

connections to be grubbed up and sealed off.

indicated by red broken lines on drawings.

Rev A RW 1st Report amendments

Project FORMER HOWGATE REST SUBDIVISION	peter	alfo	rdarch	nitect			
Title AS PROPOSED DETAIL PLANS AND ELEV	ATIONS		Howgate 01968 673911	Penicuik	Midlothian peteralfordarchite	EH26 8Q	
Drawing No 2017-BW03 Rev A	Scale 1:50	Date JUN 20	Drawn pra		ALL DIMENSIONS TO BE CHECKED ON SITE CONTRACTOR. THIS DRAWING IS COPYRIG		

Project FORMER HOWGATE REST SUBDIVISION	peteralforda				
Title AS PROPOSED DETAIL PLANS AND ELEVA	TIONS		Howgate 01968 673911	Penicuik	Midlo
Drawing No 2017-BW03 Rev A	Scale 1:50	Date JUN 20	Drawn pra	ALL DIMENSIONS CONTRACTOR. T	